


ROOF PLAN
1/16" = 1'-0"

- NOTE:
1. ALL ROOF PENETRATIONS SHOWN FOR CLARITY ONLY. VERIFY MECHANICAL DRAWINGS FOR EXACT LOCATION.
 2. REFER TO STRUCTURAL DRAWINGS FOR FRAMING OF ROOF OPENING.

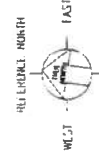


DATE	
DESCRIPTION	
REVISION NO.	
DEPARTMENTS OF THE ARMY AND AIR FORCE OFFICE OF THE ENGINEER, FT. RUGER, HAWAII	
DESIGNED BY	2ND LT. J. B. BROWN, JR.
CHECKED BY	1ST LT. J. B. BROWN, JR.
APPROVED BY	1ST LT. J. B. BROWN, JR.
DATE	
BY	
DATE	



THIS WORK WAS PREPARED BY ME OR UNDER MY SUPERVISION

IF SHEET IS LESS THAN 11" X 17" IN SIZE, THIS SCALE APPLIES TO THE ENTIRE SHEET. THE CONTRACTOR WILL BE RESPONSIBLE FOR VERIFYING THE WORK SHOWN ON THIS DRAWING AND FOR OBTAINING ALL NECESSARY PERMITS AND APPROVALS.

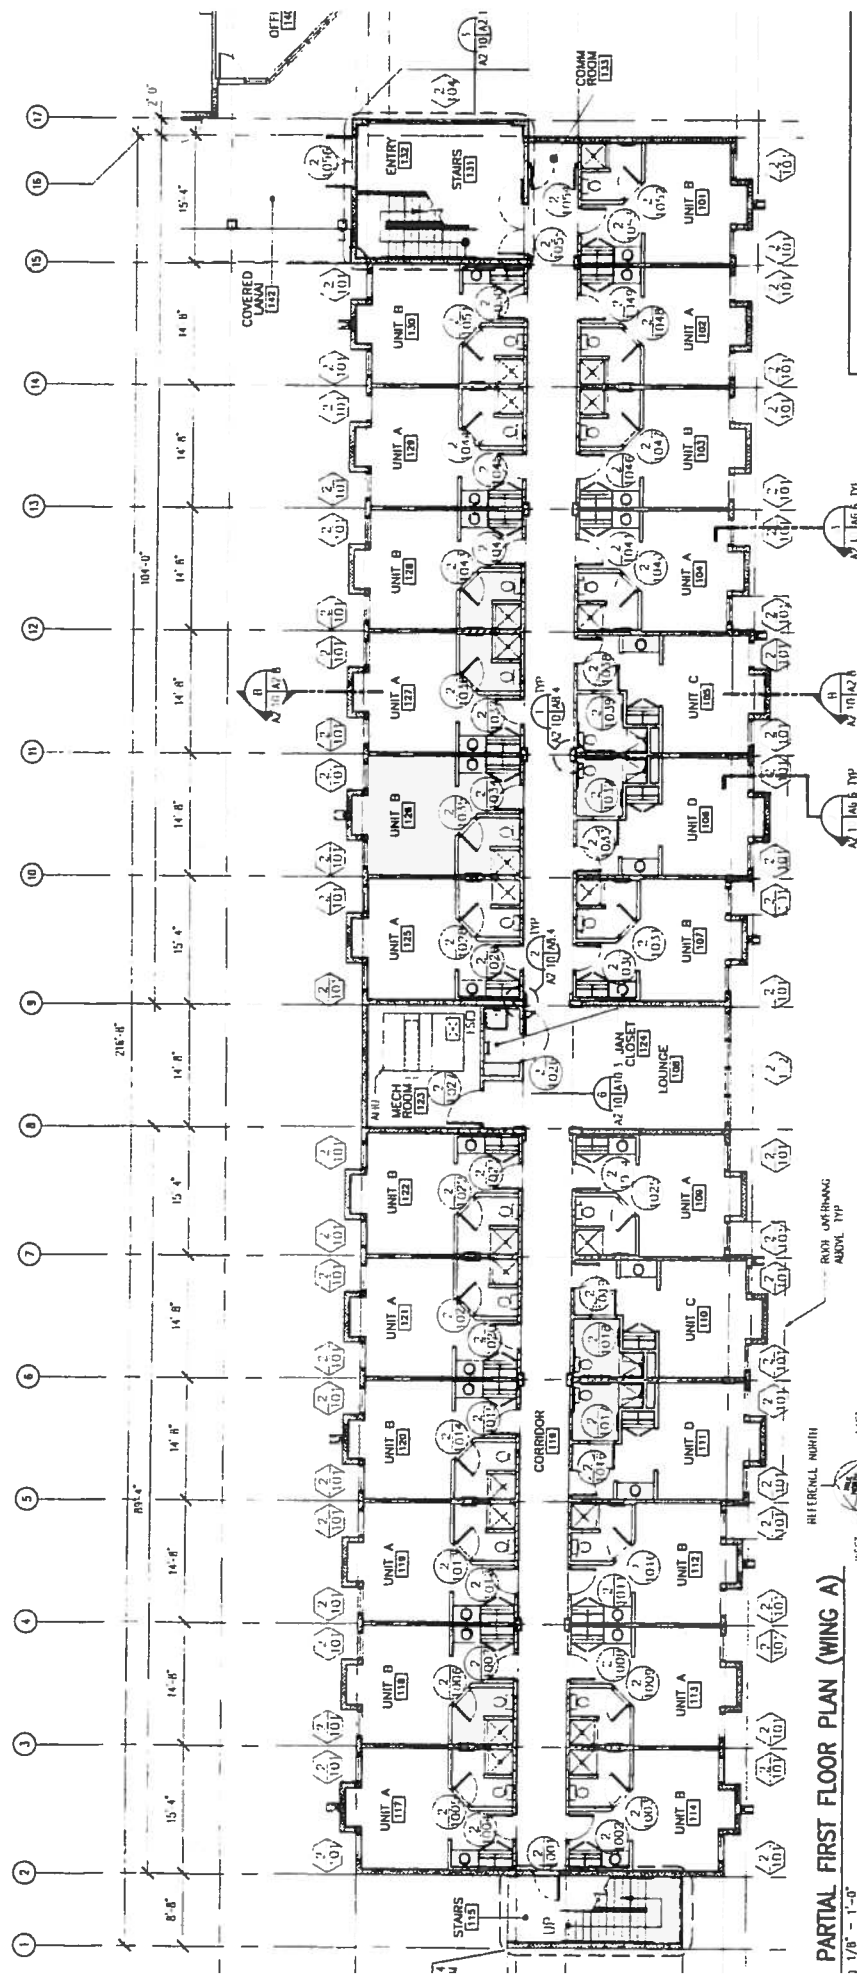

PARTIAL FIRST FLOOR PLAN (WING A)
1/8" = 1'-0"

LEGEND

- 8" CONCRETE WALL W/ CONC. BLOCK & EXTERIOR WALL
- 5/8" TYP. 1" x 1" GYP. BD. ON 3 5/8" METAL STUDS @ 24" OC ON 8" CMU WALL (ALL LATHING S. CT. W/ANSICOT) ON 5/8" CLIENT BOARD ON 3 5/8" METAL STUDS @ 16" OC 5/8" W.R. GYP. BD. ABOVE W/ANSICOT
- 5/8" TYP. 1" x 1" GYP. BD. ON 3 5/8" METAL STUDS @ 24" OC W/ER. OLGUSHS @ 24" OC (ALL BATHS, CT. W/ANSICOT) ON 5/8" CLIENT BOARD ON 3 5/8" METAL STUDS @ 16" OC 5/8" W.R. GYP. BD. ABOVE W/ANSICOT
- 5/8" TYP. 1" x 1" GYP. BD. ON 3 5/8" METAL STUDS @ 24" OC W/ANSICOT ON 5/8" CLIENT BOARD ON 3 5/8" METAL STUDS @ 16" OC 5/8" W.R. GYP. BD. ABOVE W/ANSICOT

K-F PLAN FOR BILLIT

REFERENCE NORTH

SMITH

DATE	
DESIGNED BY	
DRAWN BY	
CHECKED BY	
APPROVED BY	

DEPARTMENT OF THE ARMY AND AIR NATIONAL GUARD OF HAWAII
OFFICE OF THE ENGINEER, FT. RUCKER, HAWAII

280TH REGIONAL TRAINING INSTANT
BELLows AIR FORCE STATION
WAILANA, HAWAII


PROJECT: BILITE PARTIAL FIRST FLOOR PLAN

SCALE: 1/8" = 1'-0"



IF SHEET IS LESS THAN IT IS A REDUCED PRINT - SCALE REDUCED ACCORDINGLY

The Contractor shall be responsible for interpreting the work shown on this drawing. It is the responsibility of the Contractor to provide all necessary information and to coordinate all work within the installation limits.

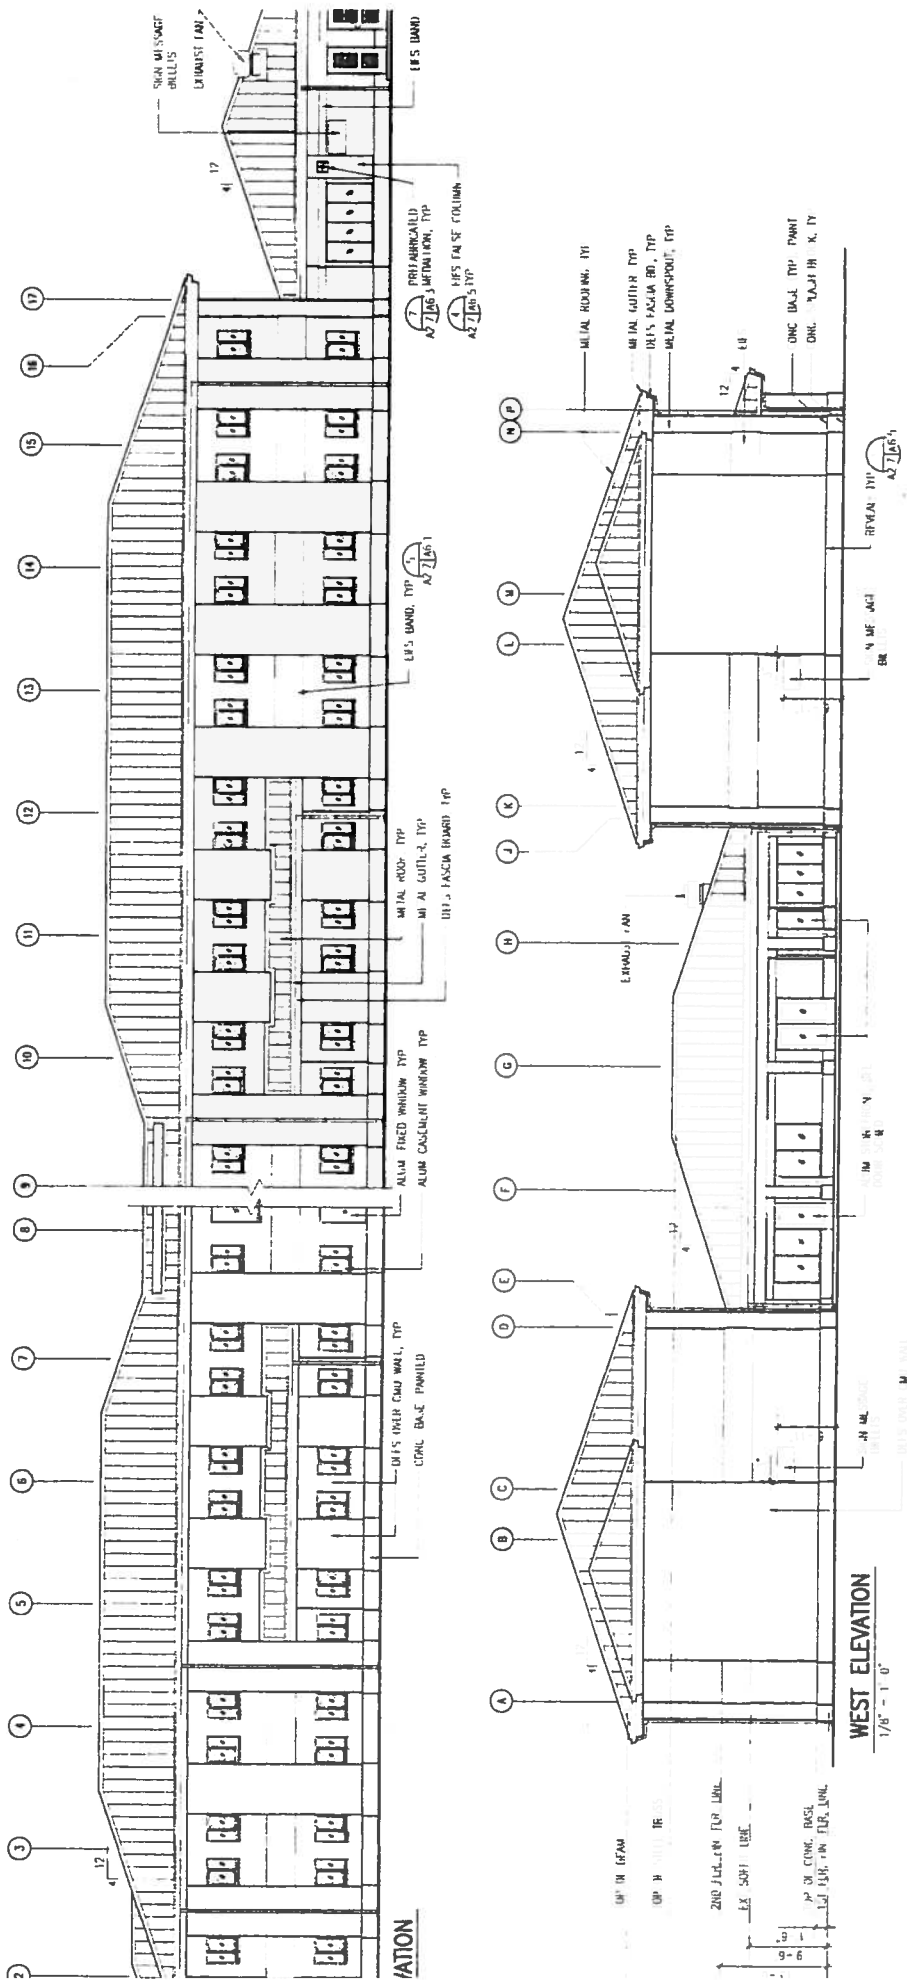

REVISION NO.	DESCRIPTION	DATE

DEPARTMENTS OF THE ARMY AND AIR
NATIONAL GUARD OF HAWAII
OFFICE OF THE ENGINEER, FT. RUGER, HAWAII

SOUTH BEACH ORDNANCE MAGAZINE
BELOW'S AIR FORCE STAT
HONOLULU, HAWAII



DESIGNED BY	
DRAWN BY	
CHECKED BY	
APPROVED BY	
DATE	

WESLEY P. LEONG
REGISTERED PROFESSIONAL ARCHITECT
NO. 10044
HAWAII, TERRITORY

THIS WORK WAS PREPARED BY ME
OR UNDER MY SUPERVISION

IF SHEET IS LESS THAN
11 1/2" x 17 1/2" IN SIZE
SCALE REDUCED ACCORDINGLY

The Contractor shall be responsible
for maintaining the work correctly
and for seeing that the work is
done in accordance with the
specifications of all work within the
contract.

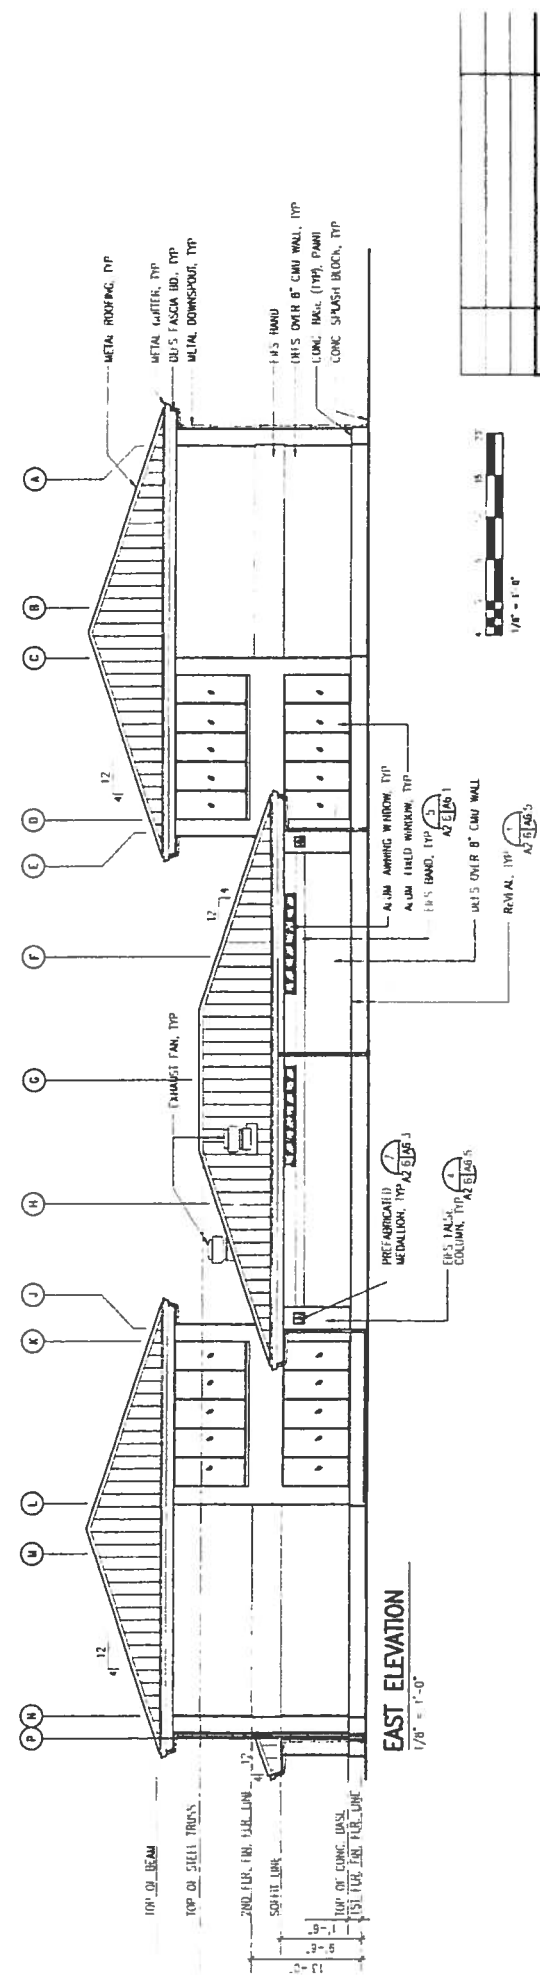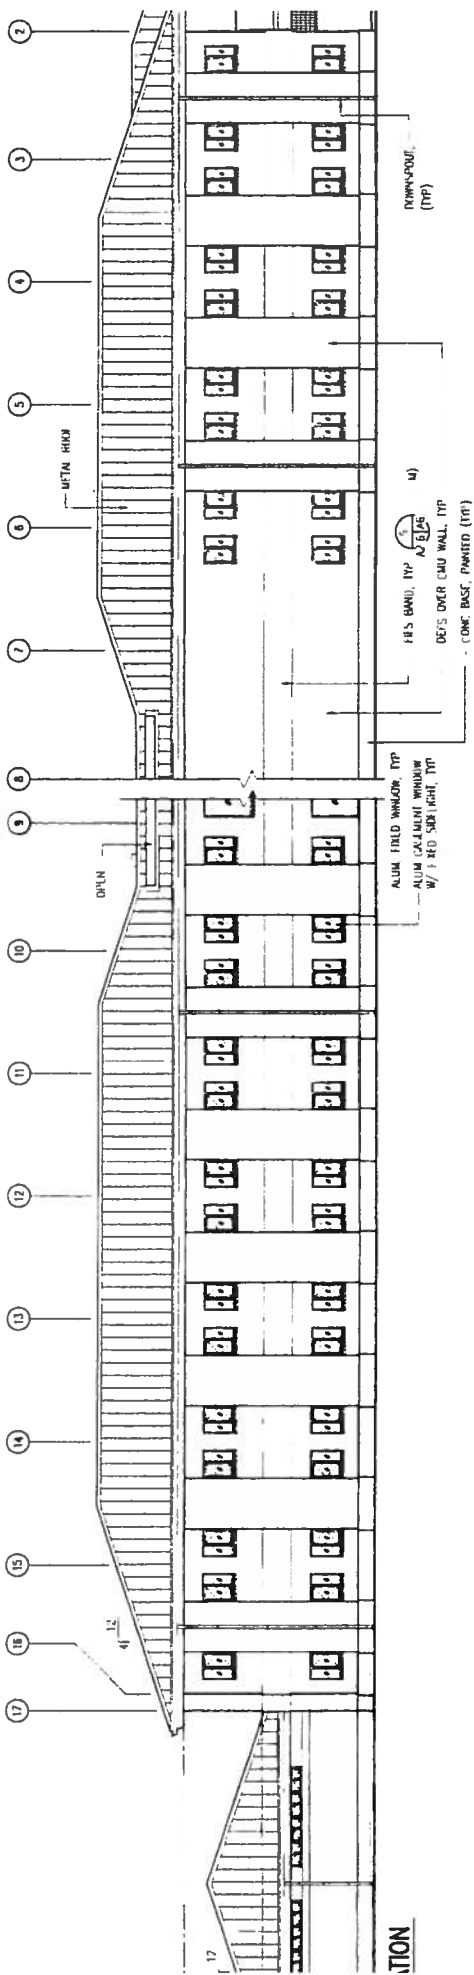

DATE	
DESIGNED BY	
CHECKED BY	
DRAWN BY	
PROJECT NO.	
SCALE	
DEPARTMENTS OF THE ARMY AND AIR NATIONAL GUARD OF HAWAII OFFICE OF THE ENGINEER, FT. RUCKER, HAWAII BELLONS AIR FORCE STA. WAIMANALO, HAWAII	
2500E NATIONAL TRAINING CENTER BLDG. 2500E EXTERIOR ELEVATIONS	
THIS DRAWING IS FORWARDED BY ME OR UNDER MY SUPERVISION	

IF SHEET IS LESS THAN
 IT IS A REDUCED PRINT.
 SCALE REDUCED ACCORDINGLY.

The Contractor shall be responsible
 for providing the necessary information
 in the various trades as necessary to
 be coordinated and to match the
 work of other trades and to match the
 available space.



EAST ELEVATION
 1/8" = 1'-0"

SECTION

